# TOWN OF CATHLAMET

WAHKIAKUM COUNTY

**WASHINGTON** 

## BOEGE ROAD AND SR 4 PRV STATIONS

### TOWN OFFICIALS

**DAVID OLSON** 

Mayor

ROBERT STOWE

KERMIT CHAMBERLIN

**JOE BAKER** 

JEANNE HENDERICKSON

LAUREL WALLER

**Town Council** 

DAVID MCNALLY

**PUBLIC WORKS SUPERINTENDENT** 



JUNE 2023 G&O JOB #22239.00

#### **WATER SYMBOLS**

EXISTING	PROPOSED	DESCRIPTION
		CAP/PLUG
#	罩	COUPLING/ADAPTER
0		GUARD POST
$\triangleright$		REDUCER
$\triangleleft$	<b>⋖</b>	THRUST BLOCK
$\boxplus$		WATER METER
W		WATER VAULT (SIZE VARIES)
	FIRE HYDRANT	
<u>-</u>		FIRE HYDRANT (3-NOZZLE)
	<u>JOINTS</u>	
	I	FLANGE/BLIND FLANGE
Γ	Г	MECHANICAL JOINT
	<u>VALVES</u>	
\$\phi^c\$		AIR RELIEF VALVE
Ŷ		BLOW-OFF VALVE
Å		BUTTERFLY VALVE
2		CHECK VALVE
$\bowtie$	H	GATE VALVE

#### SANITARY/STORM SEWER SYMBOLS

EXISTING	PROPOSED	DESCRIPTION
0		STORM DRAIN MANHOLE/TYPE 2 CATCH BASIN (ACTUAL DIMENSION SHOWN FOR PROPOSED)
		STORM DRAIN CATCH BASIN, CONCRETE INLET, OR YARD/AREA DRAIN (ACTUAL DIMENSION SHOWN FOR PROPOSED)
<u></u>		SANITARY SEWER MANHOLE (ACTUAL DIMENSION SHOWN FOR PROPOSED)

#### **GAS/POWER/TELEPHONE SYMBOLS**

EXISTING	PROPOSED	DESCRIPTION
		PAD MOUNT TRANSFORMER
Р		POWER VAULT (SIZE VARIES)
		TRANSMISSION TOWER
-0-		UTILITY POLE
$\leftarrow$		UTILITY POLE ANCHOR
		UTILITY PEDESTAL
T		TELEPHONE VAULT (SIZE VARIES)

#### **GENERAL NOTES:**

- 1. ALL MATERIALS AND WORKMANSHIP SHALL BE FURNISHED AND SUPPLIED IN ACCORDANCE WITH THE 2022 EDITION OF THE WASHINGTON STATE DEPARTMENT OF TRANSPORTATION STANDARD SPECIFICATIONS FOR ROAD, BRIDGE AND MUNICIPAL CONSTRUCTION, UNLESS OTHERWISE SPECIFICALLY NOTED.
- 2. THE CONTRACTOR SHALL BE RESPONSIBLE TO CONTACT AND COORDINATE WITH ALL UTILITY COMPANIES IN ORDER TO ASSURE THAT ALL LINES, PIPES, POLES AND OTHER APPURTENANCES ARE PROPERLY LOCATED, SECURED, AND/OR PROTECTED. BURIED UTILITIES (WHERE KNOWN) ARE SHOWN IN THEIR APPROXIMATE LOCATION. THE CONTRACTOR SHALL HAVE UTILITIES VERIFIED ON THE GROUND PRIOR TO ANY CONSTRUCTION. NOTIFY THE UNDERGROUND UTILITIES LOCATE CENTER: 1-800-424-5555.
- 3. ON-SITE EROSION AND SEDIMENT CONTROL MEASURES ARE REQUIRED AND SHALL BE THE RESPONSIBILITY OF THE CONTRACTOR.
- 4. THE CONTRACTOR SHALL HAVE A COPY OF THESE PLANS, ANY ADDENDA, CHANGE ORDERS, AND THE CONTRACT SPECIFICATIONS ON THE JOB SITE WHENEVER CONSTRUCTION IS IN PROGRESS.
- 5. THE CONTRACTOR SHALL PROMPTLY NOTIFY THE ENGINEER IN THE EVENT OR DISCOVERY OF UNSUITABLE SOILS OR HIGH GROUND WATER CONDITIONS OR DISCREPANCIES FROM THE PLANS.
- 6. THE CONTRACTOR SHALL MAINTAIN A CLEAN LEGIBLE SET OF RECORD DRAWINGS AND PROVIDE A SET TO THE OWNER PRIOR TO DEMOBILIZATION OF THE SITE. SEE SPECIFICATIONS.

#### SIGNALIZATION/ILLUMINATION SYMBOLS

EXISTING	PROPOSED	DESCRIPTION
		JUNCTION BOX (TYPE I, II, VIII)
$\Diamond \longrightarrow \!$		LIGHT/LUMINAIRE POLE W/ARM

#### SURFACE FEATURES/LANDSCAPING


EXISTING	PROPOSED	DESCRIPTION
		BUILDING
Д		SIGN
M		TREE STUMP
		SHRUB
NOTED		TREE (CONIFER)
NOTED		TREE (DECIDUOUS)

#### **SURVEY SYMBOLS**

EXISTING	PROPOSED	DESCRIPTION
Δ		CONTROL POINT
•		MONUMENT (IN CASE)
<b>@</b>		MONUMENT (SURFACE)
<del>+</del>		BENCH MARK
•		BOUNDARY/PROPERTY CORNER
0		IRON PIPE



8513 NE HAZEL DELL AVENUE, SUITE 202 VANCOUVER, WA 98665 (360) 571-3350

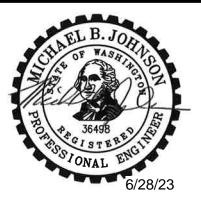





**TOWN OF CATHLAMET** 

**BOEGE ROAD** AND SR 4 PRV STATIONS

0.	DATE	REVISION

ISSUED FOR:

BID AND CONSTRUCTION

ISSUE DATE:	JUNE 2023
APPROVED BY:	MBJ
CHECKED BY:	ANM
DRAWN BY:	RAH
DESIGNER:	ANM
G & O JOB NO.:	22239
FILE:	LEGEND.DWG

TWO INCHES AT FULL SCALE IF NOT, SCALE ACCORDINGLY

**GENERAL** 

ABBREVIATIONS, LINETYPE LEGEND, AND SYMBOL LEGEND

DRAWING: **G-1** OF: **9** 

**PVMT** 

PVT QTY

R/W

RED

REINF

REQD

RET

SCH

SHT

SPECS

SQ

STA

STD

TB

TEL

TESC

THRD

THRU

TYP

VERT

WSDOT

POWER POLE

PAVEMENT

QUANTITY RADIUS

REDUCER

REINFORCE

REQUIRED

RETAINING RAILROAD

SCHEDULE

SQUARE FEET

SPECIFICATIONS

THRUST BLOCK

TOP OF CURB

TELEPHONE

THREADED

THROUGH

TYPICAL

VERTICAL WEST

WITH WITHOUT

SOUTH

SHEET SLOPE

SQUARE

STATION STANDARD

RIGHT-OF-WAY


POINT OF TANGENCY POLYVINYL CHLORIDE

POINT OF VERTICAL INTERSECTION

POINT OF VERTICAL TANGENT

WASHINGTON STATE DEPARTMENT OF TRANSPORTATION

TEMPORARY EROSION AND SEDIMENT CONTROL

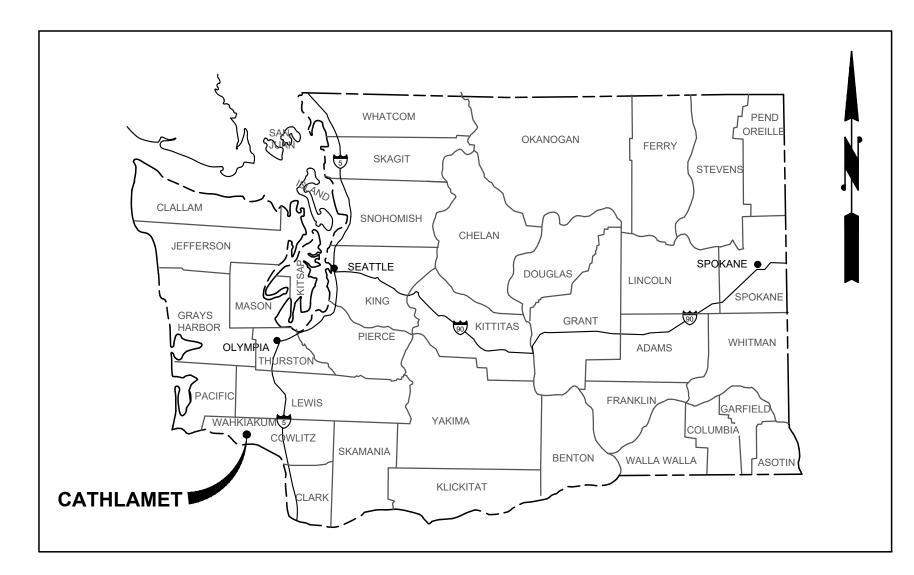



SHEET INDEX	
SHEET NO	DESCRIPTION
	COVER
GENERAL	
G-1	ABBREVIATIONS, LINETYPE LEGEND, AND SYMBOL LEGEND
G-2	VICINITY MAP, LOCATION MAP, AND SHEET INDEX
G-3	SURVEY CONTROL
G-4	SITE PLAN
G-5	PRV 1 AND 2 PIPING DETAILS
G-6	TEMPORARY EROSION AND SEDIMENT CONTROL NOTES AND DETAILS
G-7	TRENCHING, RESTORATION, AND WATER DETAILS
G-8	PRV 1 AND PRV 2 VAULT PLANS AND SECTIONS
G-9	TRAFFIC CONTROL PLAN

#### PROJECT CONTACT INFORMATION:

#### OWNER CONTACT

TOWN OF CATHLAMET 375 2ND STREET CATHLAMET, WA 98612

DAVID MCNALLY PUBLIC WORKS SUPERINTENDENT DAVID@TOWNOFCATHLAMET.COM (360)751-0257

ENGINEER CONTACT GRAY & OSBORNE, INC. 8513 NE HAZEL DELL AVE, SUITE 202 VANCOUVER, WA 98665

ABBEY MCDONALD, P.E. AMCDONALD@G-O.COM (360)571-3350

#### PRV STATION 1 DESIGN CRITERIA:

ELEVATION (CENTERLINE)

SIZE

UPSTREAM PRESSURE

DOWNSTREAM PRESSURE

230 FT

(1) 2-INCH, (1) 6-INCH

81 PSI

68 PSI

#### PRV STATION 2 DESIGN CRITERIA:

ELEVATION (CENTERLINE)

SIZE

UPSTREAM PRESSURE


DOWNSTREAM PRESSURE

218 FT

(1) 2-INCH, (1) 6-INCH

86 PSI

73 PSI

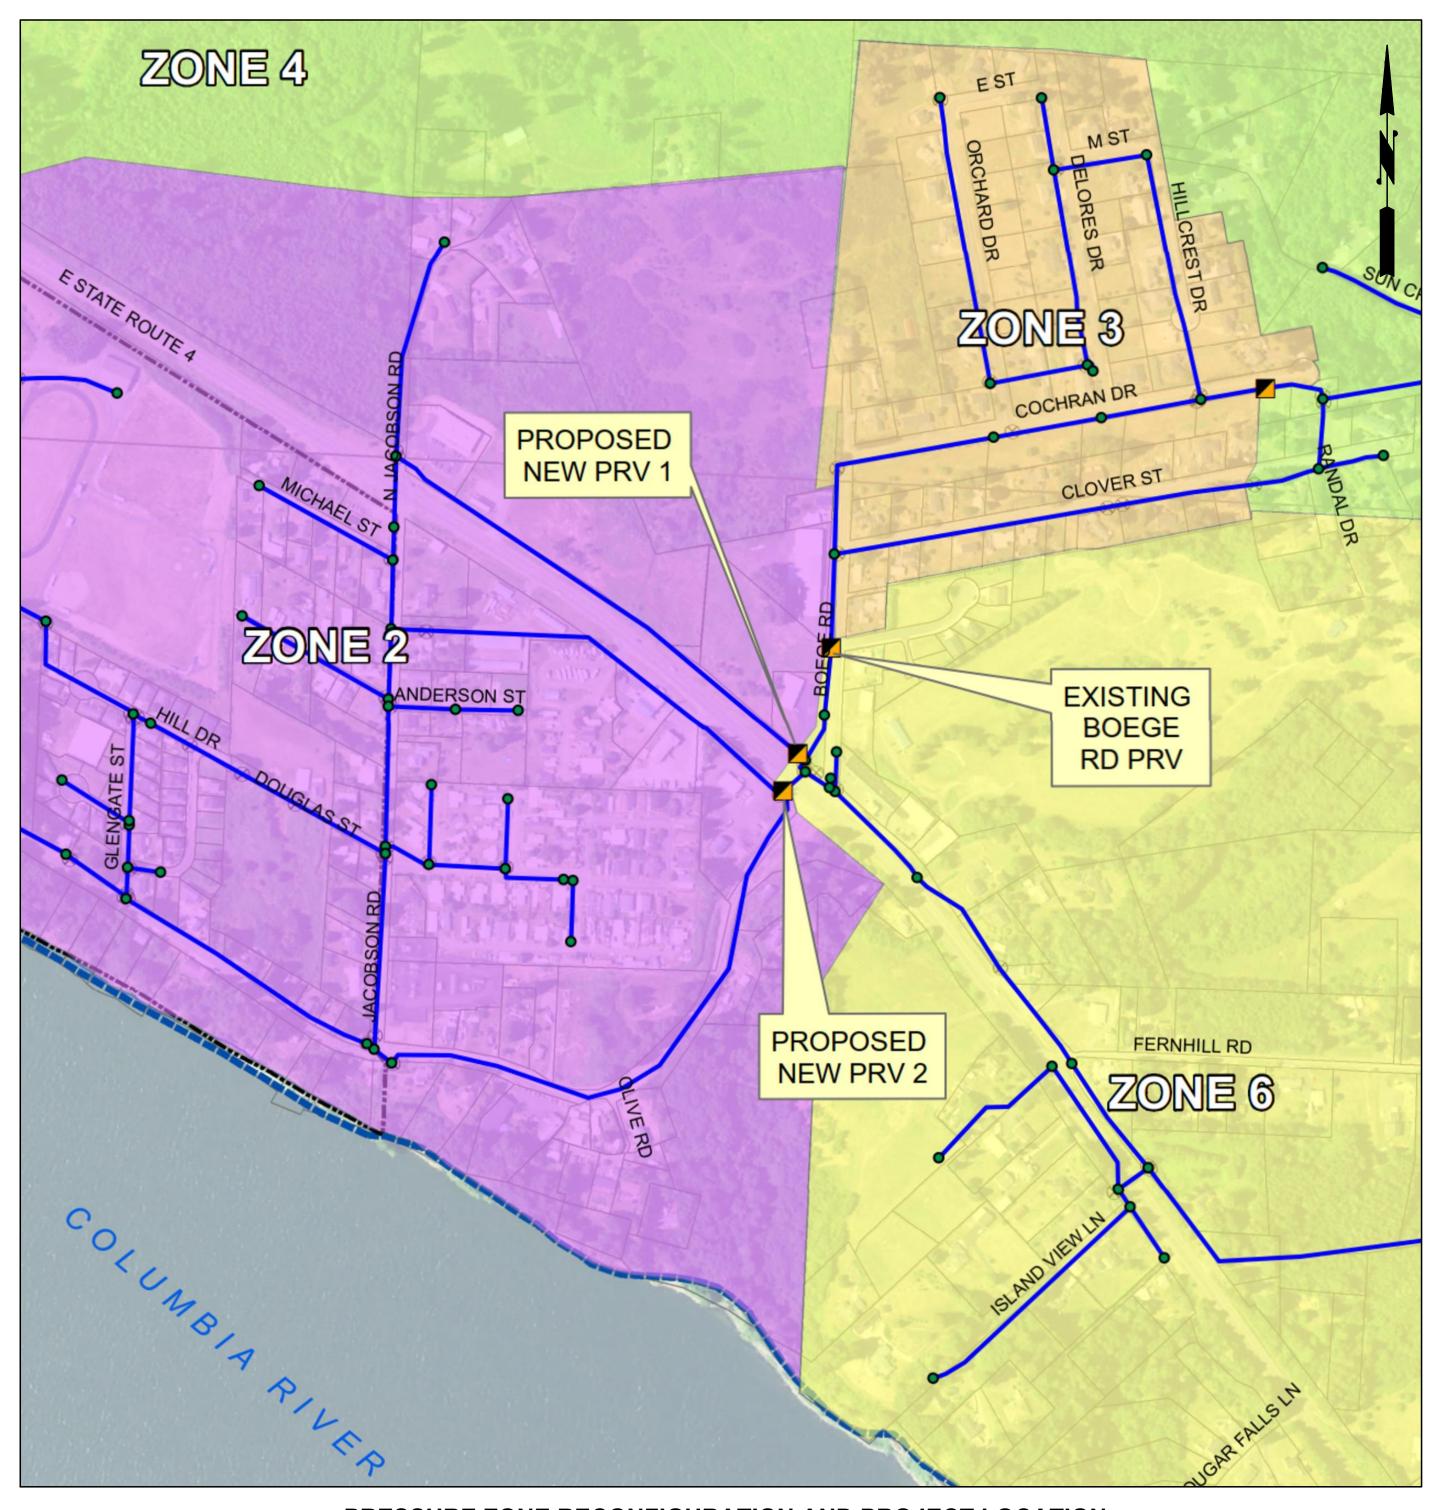


PRESSURE ZONE RECONFIGURATION AND PROJECT LOCATION

SCALE: 1:300





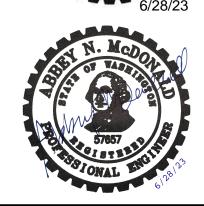




BOEGE ROAD AND SR 4 PRV STATIONS

No.	DATE	REVISION
SSUED FOR:		
	BID AND	CONSTRUCTION
SSUE DATE:		JUNE 2023
APPROVED BY:		MBJ
	· · · · · · · · · · · · · · · · · · ·	

CHECKED	BY:	ANM
DRAWN B	Y:	RAH
DESIGNER	₹:	ANM
G & O JOB NO.:		22239
FILE:	VIC_LOC	_INDEX.DWG
_		

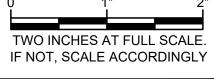

**GENERAL** 


VICINITY MAP, LOCATION MAP, AND SHEET INDEX

DRAWING: **G-2** OF: **9** 

914803.09 | 251.82 | SFRC, 5/8" REBAR W/ YELLOW PLASTIC "HAMPSTUR CORP LS 18267" CAP.

914800.26 | 245.94 | SFRC, 5/8" REBAR W/ YELLOW PLASTIC "HAMPSTUR CORP LS 18267" CAP.


243.14 SFR, 3/8" REBAR W/ FLAGGING. DOWN 0.35' BELOW F/G.

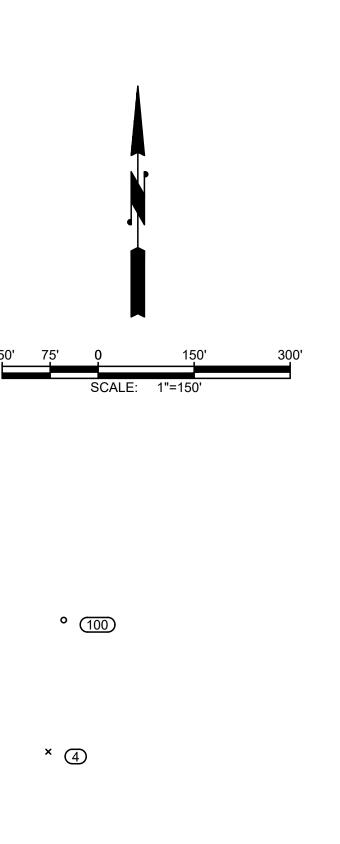

**9** ②



× (102) (a) (1)

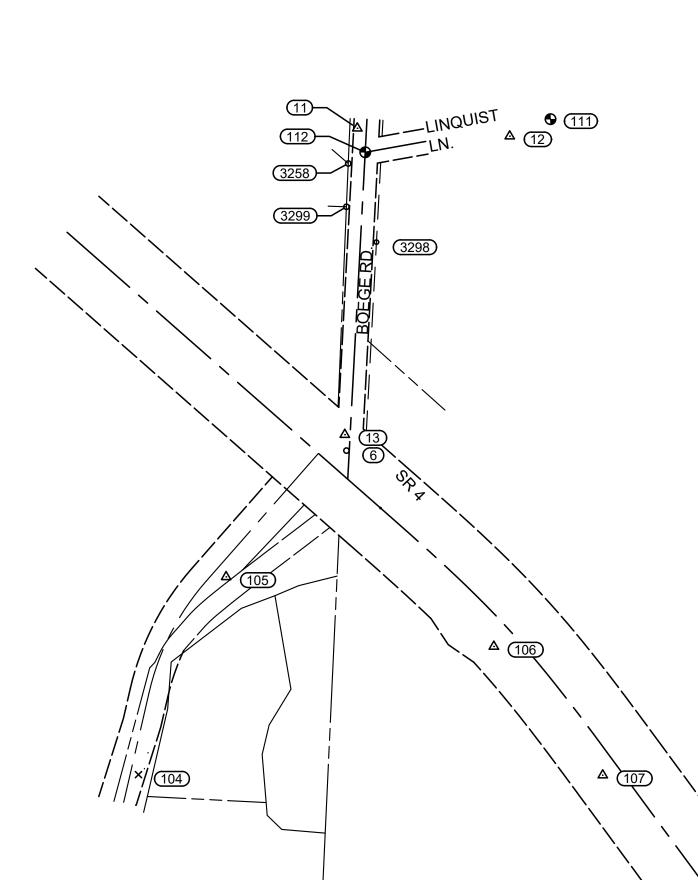


**SURVEY CONTROL** 

SCALE: 1"=150'

Gray & Osborne, Inc.

8513 NE HAZEL DELL AVENUE SUITE 202 VANCOUVER, WA 98665 (360) 571-3350

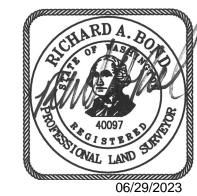





**TOWN OF CATHLAMET** 

**BOEGE ROAD** AND SR 4 PRV STATIONS

No. DATE REVISION ISSUED FOR:

BID AND CONSTRUCTION ISSUE DATE: JUNE 2023 APPROVED BY: ANM CHECKED BY:

DRAWN BY: RAH DESIGNER: ANM G & O JOB NO.: 22239 SURVEY.DWG

TWO INCHES AT FULL SCALE IF NOT, SCALE ACCORDINGLY

**GENERAL** 

**SURVEY CONTROL** 

DRAWING: **G-3** OF: **9** 

**RIGHT-OF-WAY DISCLAIMER** 

328684.32

328561.50


328616.70

914847.07

3258

3298


THE RIGHT-OF-WAY AND/OR PROPERTY LINES SHOWN HEREON ARE BASED ON AVAILABLE INFORMATION, NOT ON A SURVEYED LOCATION AND ARE ONLY APPROXIMATE.

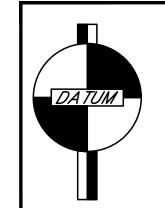

**DATUM** 

**VERTICAL: HORIZONTAL:** 

**VERTICAL DATUM - NGVD29 HORIZONTAL DATUM - NAD83/11** W.S.P.C.S. S. ZONE

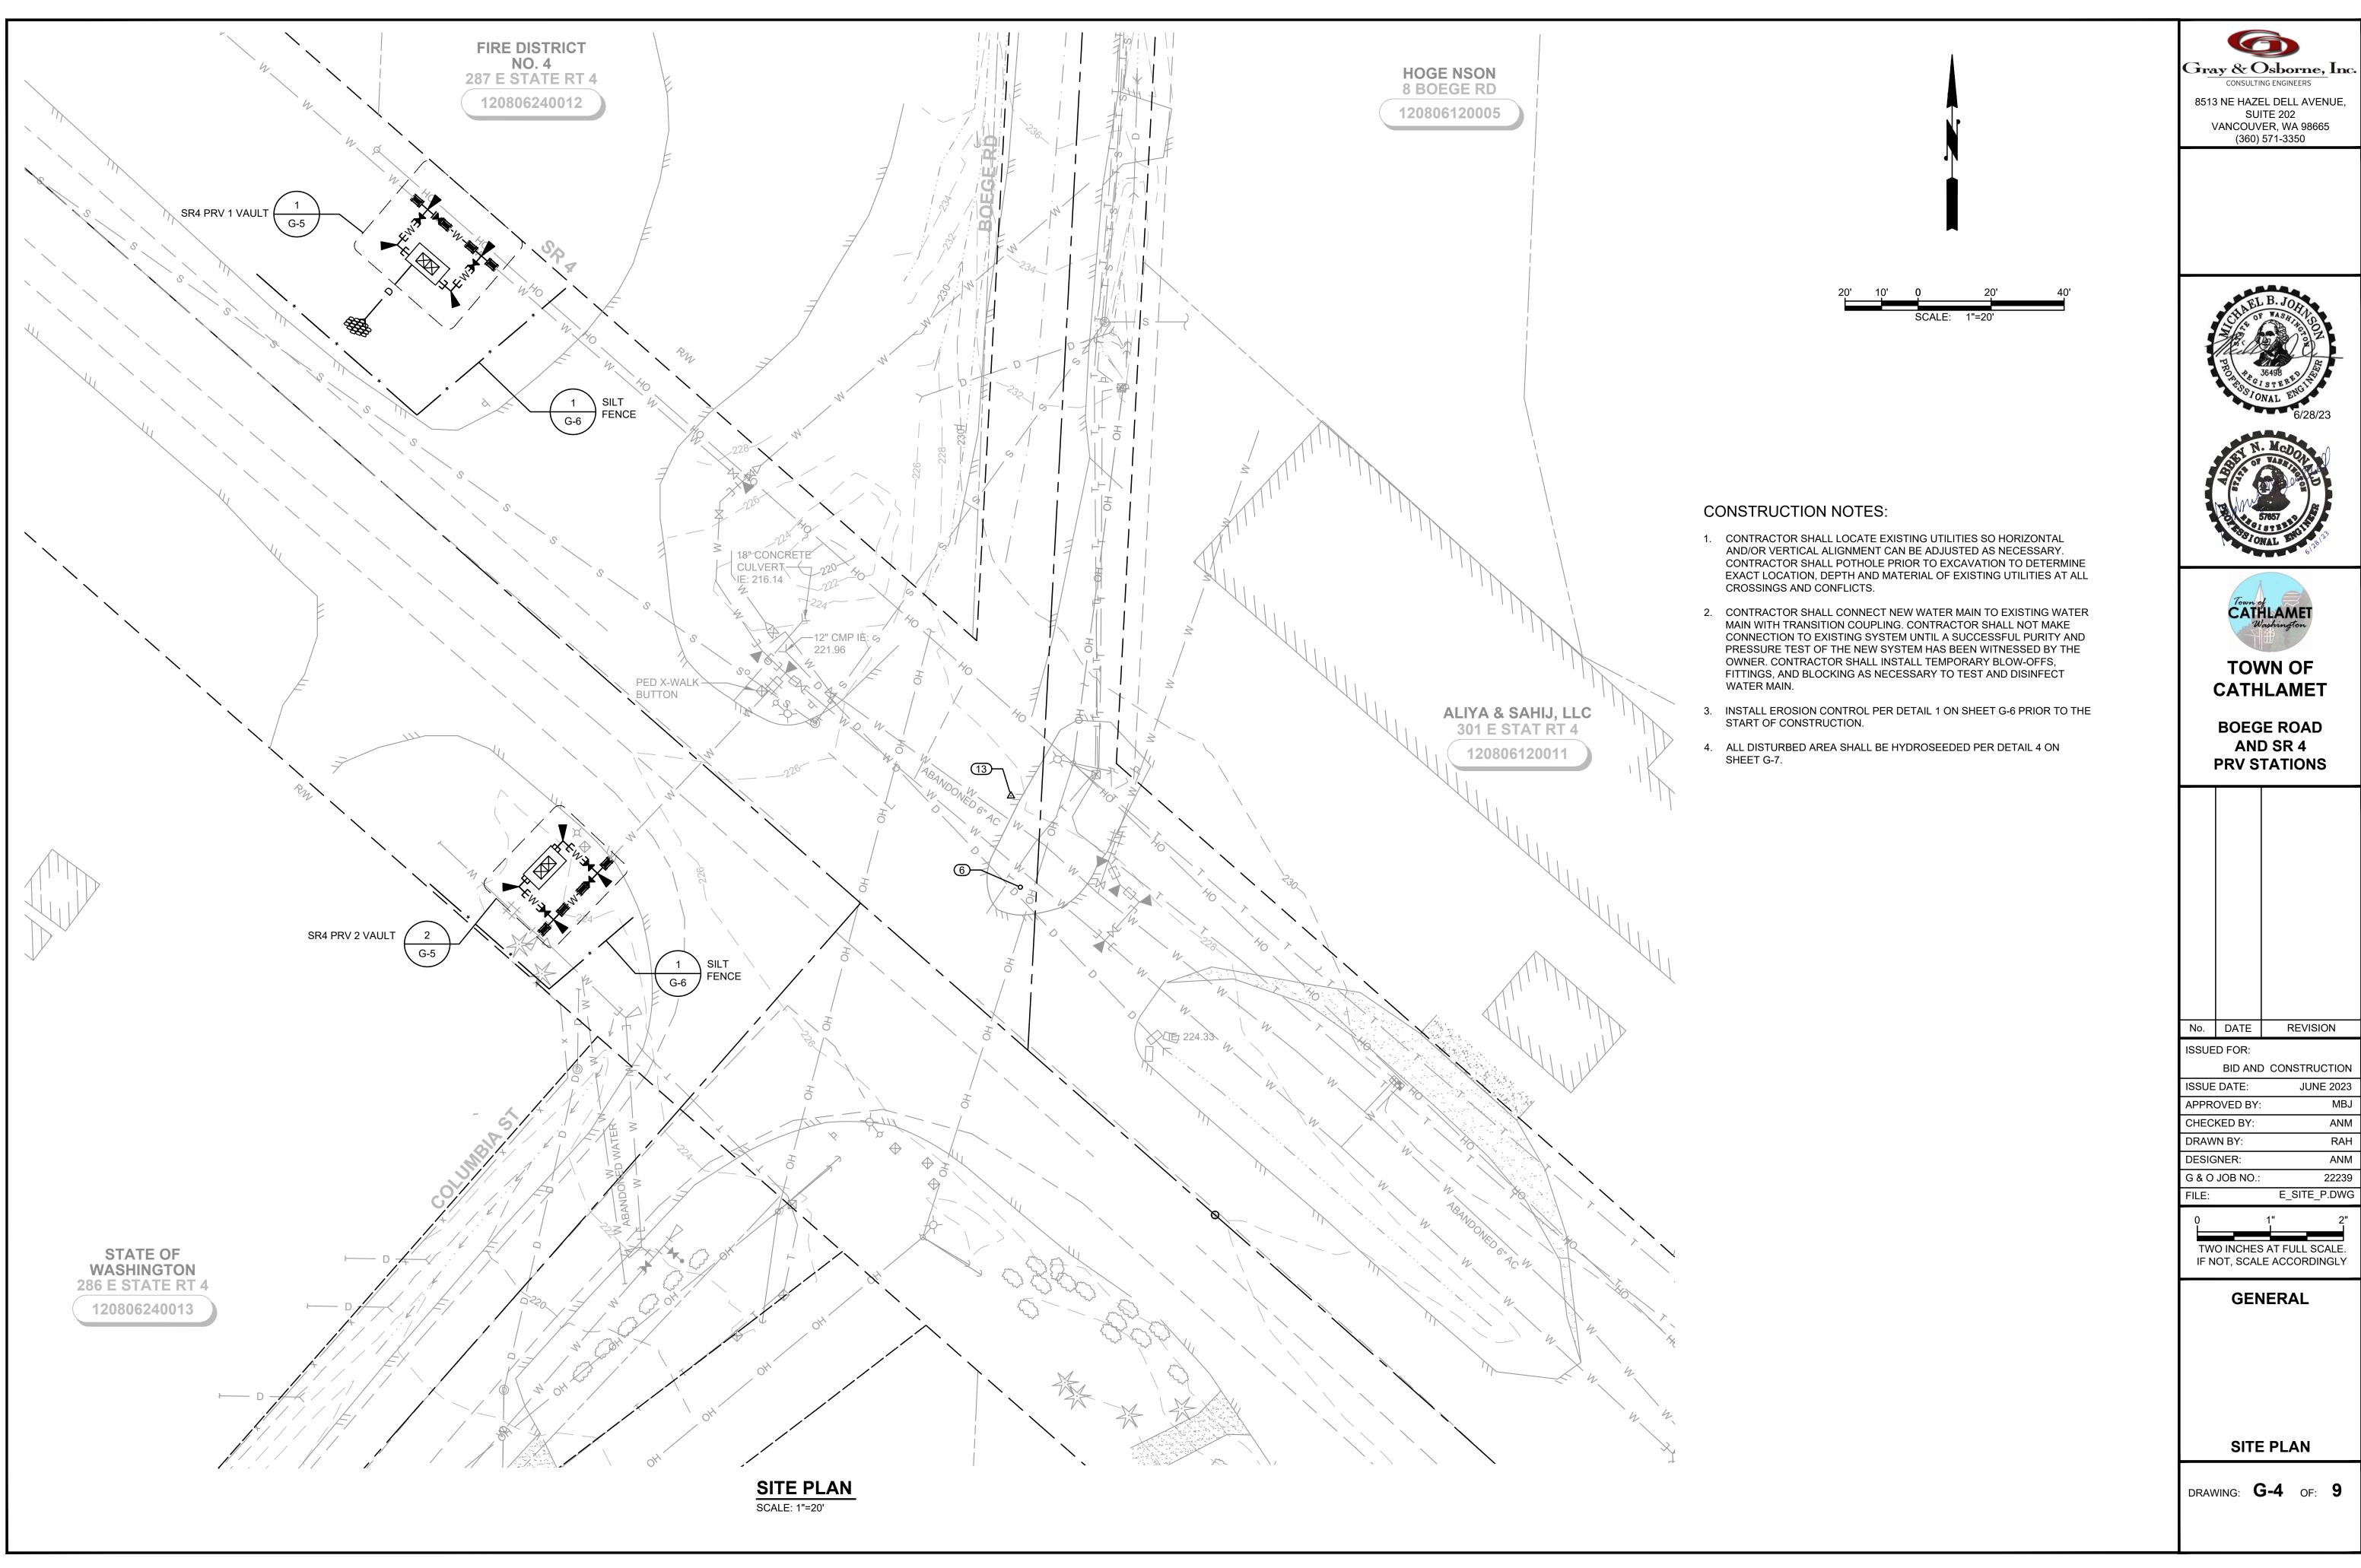

Gray & Osborne, Inc.

VANCOUVER, WA 98665 (360) 571-3350







**CATHLAMET** 

AND SR 4 **PRV STATIONS** 

No. DATE REVISION

ISSUE DATE:	JUNE 2023
APPROVED BY:	MBJ
CHECKED BY:	ANM
DRAWN BY:	RAH
DESIGNER:	ANM
G & O JOB NO.:	22239


TWO INCHES AT FULL SCALE.
IF NOT, SCALE ACCORDINGLY

CONTROL TABLE					
	DESCRIPTION	ELEVATION	NORTHING	EASTING	
1	6" 90° BEND (MJ) w/ THRUST BLOCK	229.27	328,411.76	914,629.56	
2	6" 90° BEND (MJ) w/ THRUST BLOCK	229.27	328,399.04	914,644.28	
3	CORNER OF PRV VAULT	236.00	328,407.80	914,631.82	
4	CORNER OF PRV VAULT	236.00	328,405.20	914,643.92	
5	8" x 6" TEE (FL) w/ THRUST BLOCK	227.66	328,421.41	914,637.91	
6	8" x 6" TEE (FL) w/ THRUST BLOCK	227.66	328,408.70	914,652.63	
7	6" 90° BEND (MJ) w/ THRUST BLOCK	217.22	328,248.44	914,674.97	
8	6" 90° BEND (MJ) w/ THRUST BLOCK	217.22	328,235.88	914,662.93	
9	CORNER OF PRV VAULT	223.01	328,247.09	914,671.65	
10	CORNER OF PRV VAULT	223.01	328,235.16	914,668.38	
11	6" TEE (FL) w/ THRUST BLOCK	220.29	328,226.89	914,672.39	
12	6" TEE (FL) w/ THRUST BLOCK	221.25	328,239.56	914,684.37	

\\\	\\\	SR 4	\\\		
		DRAIN TO DAYLIGNT			
		4" CPEP			
	G-8 SR4 PRV V	AULT 1 —	3		
	2	2			
FURNISH AND INSTALL –		6 PRESSURE RELIEF PIPING	M _ ELIB		
(1) 8" x 6" TEE (FL) w / THRUST BLOCK (1) 6" GATE VALVE (FLXM) (1) 8" GATE VALVE (FLXM) (2) FLEXIBLE COUPLINGS	6	— W — W — W	(1) 8 (1) 8 (1) 6 (2) F	INISH AND INSTALL  " x 6" TEE (FL)  " / THRUST BLOCK " GATE VALVE (FLxMJ) FLEXIBLE COUPLINGS	
OH OH OH OH OH CONTRACTOR TO VERIFY MATERIAL OF EXISTING MAIN	ОН ОН		- OH OH	OH O	— ОН —
· — — — — — — — — — — — — — — — — — — —	FIRE DISTRICT NO. 4				
	287 E STATE RT 4 120806240012				

#### CONSTRUCTION NOTES:

- 1. CONTRACTOR SHALL LOCATE EXISTING UTILITIES SO HORIZONTAL AND/OR VERTICAL ALIGNMENT CAN BE ADJUSTED AS NECESSARY. CONTRACTOR SHALL POTHOLE PRIOR TO EXCAVATION TO DETERMINE EXACT LOCATION, DEPTH AND MATERIAL OF EXISTING UTILITIES AT ALL CROSSINGS AND CONFLICTS.
- 2. CONTRACTOR SHALL CONNECT NEW WATER MAIN TO EXISTING WATER MAIN WITH TRANSITION COUPLING. CONTRACTOR SHALL NOT MAKE CONNECTION TO EXISTING SYSTEM UNTIL A SUCCESSFUL PURITY AND PRESSURE TEST OF THE NEW SYSTEM HAS BEEN WITNESSED BY THE OWNER. CONTRACTOR SHALL INSTALL TEMPORARY BLOW-OFFS, FITTINGS, AND BLOCKING AS NECESSARY TO TEST AND DISINFECT WATER MAIN.
- INSTALL EROSION CONTROL PER DETAIL 1 ON SHEET G-6 PRIOR TO START OF CONSTRUCTION.
- 4. ALL DISTURBED AREA SHALL BE HYDROSEEDED PER DETAIL 4 ON SHEET G-7.
- 5. ALL PIPING TO BE RESTRAINED.

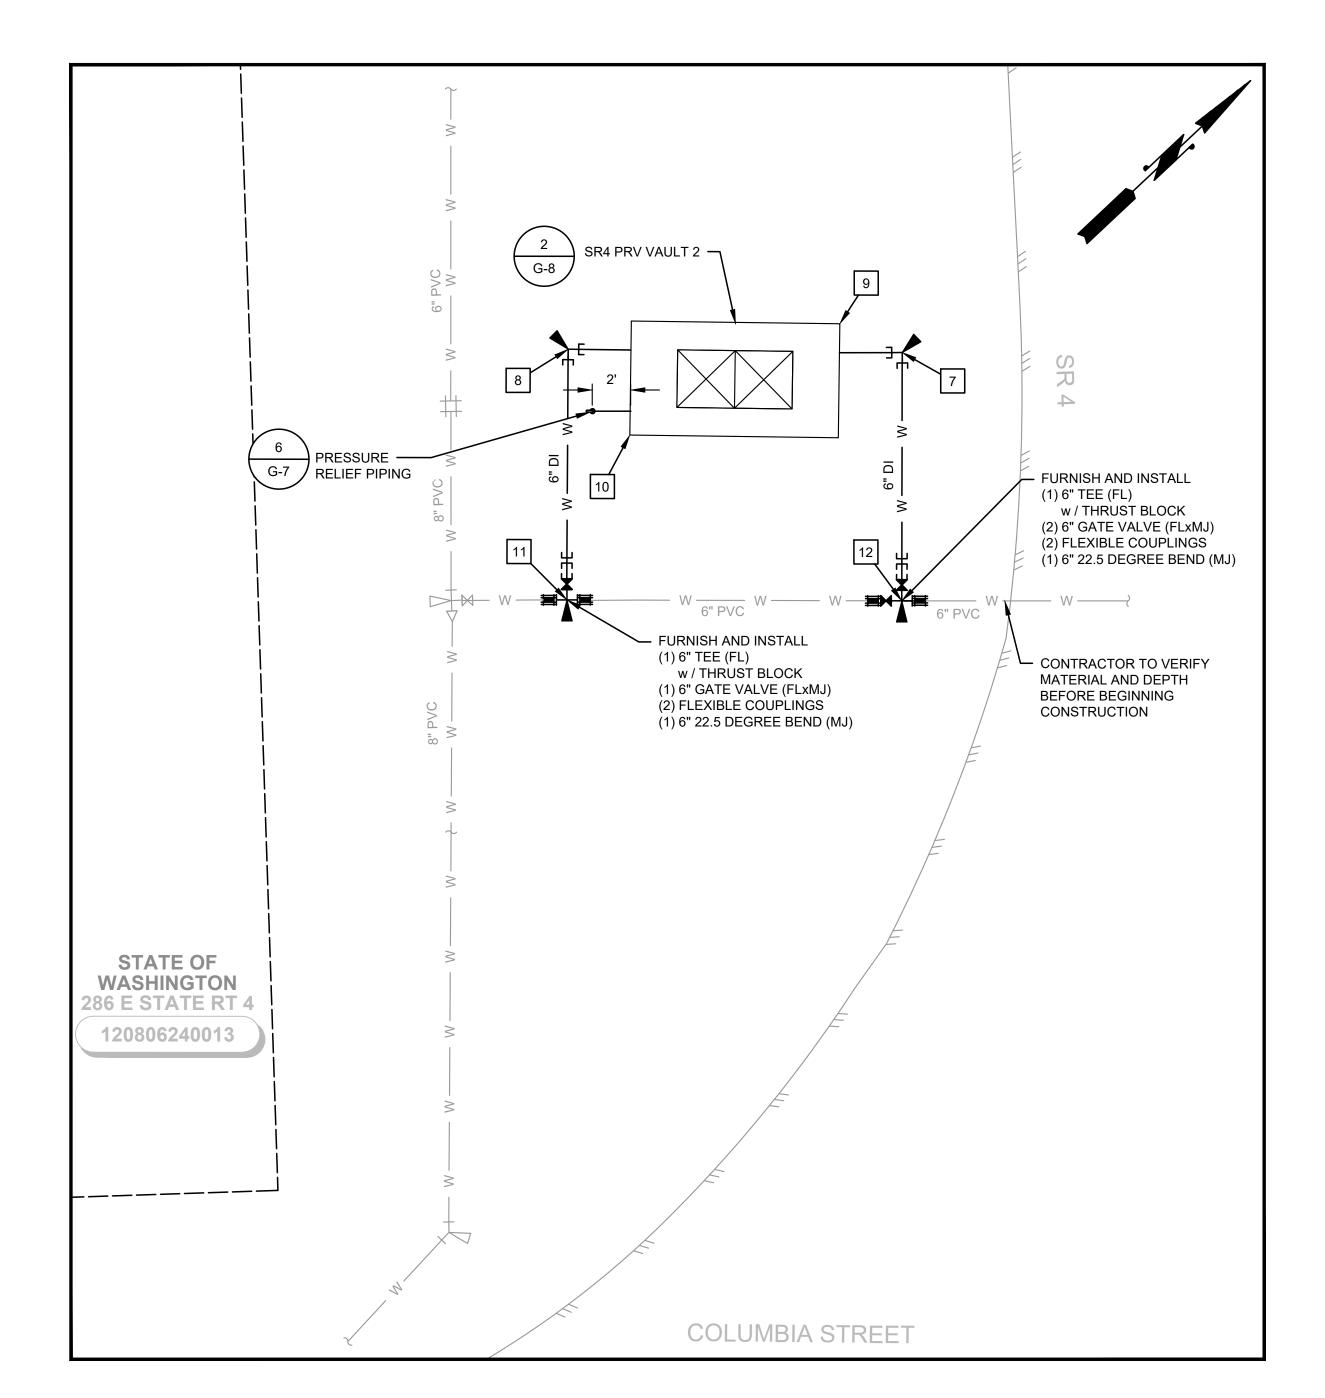

PRV 2 PIPING DETAILS

SCALE: 1"=5'

Gray & Osborne, Inc.

CONSULTING ENGINEERS


8513 NE HAZEL DELL AVENUE,

SUITE 202

VANCOUVER, WA 98665

(360) 571-3350

TONAL ENGINEERS 10NAL ENGINEER

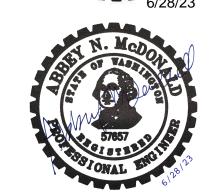



TOWN OF CATHLAMET

BOEGE ROAD AND SR 4 PRV STATIONS

No. DATE REVISION

ISSUED FOR:

G & O JOB NO.:

BID AND CONSTRUCTION

ISSUE DATE: JUNE 2023

APPROVED BY: MBJ

CHECKED BY: ANM

DRAWN BY: RAH

DESIGNER: ANM

22239

E\_SITE\_P.DWG

0 1" 2"
TWO INCHES AT FULL SCALE.
IF NOT, SCALE ACCORDINGLY


GENERAL

PRV 1 AND 2 PIPING DETAILS

drawing: **G-5** of: **9** 

#### **EROSION/SEDIMENTATION CONTROL NOTES**

- ALL LIMITS OF CLEARING AND AREAS OF VEGETATION PRESERVATION SHALL BE OBSERVED DURING CONSTRUCTION.
- 2. ALL REQUIRED SEDIMENTATION/EROSION CONTROL FACILITIES MUST BE IN OPERATION PRIOR TO LAND CLEARING AND/OR OTHER CONSTRUCTION TO INSURE THAT SEDIMENT LADEN WATER DOES NOT ENTER THE NATURAL DRAINAGE SYSTEM. ALL EROSION AND SEDIMENT FACILITIES SHALL BE MAINTAINED IN A SATISFACTORY CONDITION UNTIL SUCH TIME THAT CLEARING AND /OR CONSTRUCTION IS COMPLETED AND THE POTENTIAL FOR ON-SITE EROSION HAS PASSED. THE IMPLEMENTATION, MAINTENANCE, REPLACEMENT AND ADDITIONS TO EROSION/SEDIMENTATION CONTROL SYSTEMS SHALL BE THE RESPONSIBILITY OF THE CONTRACTOR.
- 3. THE EROSION AND SEDIMENTATION CONTROL SYSTEMS DEPICTED ON THIS DRAWING ARE INTENDED TO BE MINIMUM REQUIREMENTS TO MEET ANTICIPATED SITE CONDITIONS. AS CONSTRUCTION PROGRESSES AND AS UNEXPECTED OR SEASONAL CONDITIONS DICTATE, THE CONTRACTOR SHOULD ANTICIPATE THAT MORE EROSION AND SEDIMENTATION CONTROL
- FACILITIES WILL BE NECESSARY TO INSURE COMPLETE SILTATION CONTROL ON THE PROPOSED SITE. DURING THE COURSE OF CONSTRUCTION, IT SHALL BE THE OBLIGATION AND RESPONSIBILITY OF THE CONTRACTOR TO ADDRESS ANY NEW CONDITIONS THAT MAY BE CREATED BY HIS ACTIVITIES AND TO PROVIDE ADDITIONAL FACILITIES, OVER AND ABOVE THE MINIMUM REQUIREMENTS, AS MAY BE NEEDED TO PROTECT ADJACENT PROPERTIES AND THE WATER QUALITY OF THE RECEIVING DRAINAGE SYSTEM.
- 4. AT NO TIME SHALL MORE THAN ONE FOOT OF SEDIMENT BE ALLOWED TO ACCUMULATE WITHIN A CATCH BASIN. THE CONTRACTOR SHALL BE RESPONSIBLE FOR REMOVING AND DISPOSING OF THE SEDIMENT. ALL CATCH BASINS, CONVEYANCE LINES AND DITCHES SHALL BE CLEANED PRIOR TO PAVING.
- 5. THE CONTRACTOR SHALL REMOVE MATERIAL DROPPED, WASHED OR TRACKED FROM VEHICLES ONTO THE COUNTY RIGHT-OF-WAY OR INTO THE EXISTING STORM DRAINAGE SYSTEM. DEBRIS SHALL NOT BE WASHED INTO THE STORM DRAINAGE SYSTEM.
- 6. TEMPORARY EROSION CONTROL FACILITIES SHALL BE INSPECTED WEEKLY AND MAINTAINED WITHIN 24 HOURS FOLLOWING A STORM EVENT. SEDIMENT SHALL BE REMOVED TO INSURE THE FACILITIES WILL FUNCTION PROPERLY. THE FACILITIES SHALL BE SATISFACTORILY MAINTAINED UNTIL CONSTRUCTION IS COMPLETED AND THE POTENTIAL FOR ON-SITE EROSION HAS PASSED.
- 7. ALL STORM DRAIN INLETS MADE OPERABLE DURING CONSTRUCTION SHALL BE PROTECTED SO THAT STORMWATER RUNOFF SHALL NOT ENTER THE CONVEYANCE SYSTEM WITHOUT FIRST BEING FILTERED OR OTHERWISE TREATED TO REMOVE SEDIMENT.
- 8. NO DISTURBED SOIL SHALL REMAIN UNSTABILIZED FOR MORE THAN TWO DAYS.
- 9. CONTRACTOR MAY INSTALL COMPOST BERMS IN LIEU OF SILT FENCE.

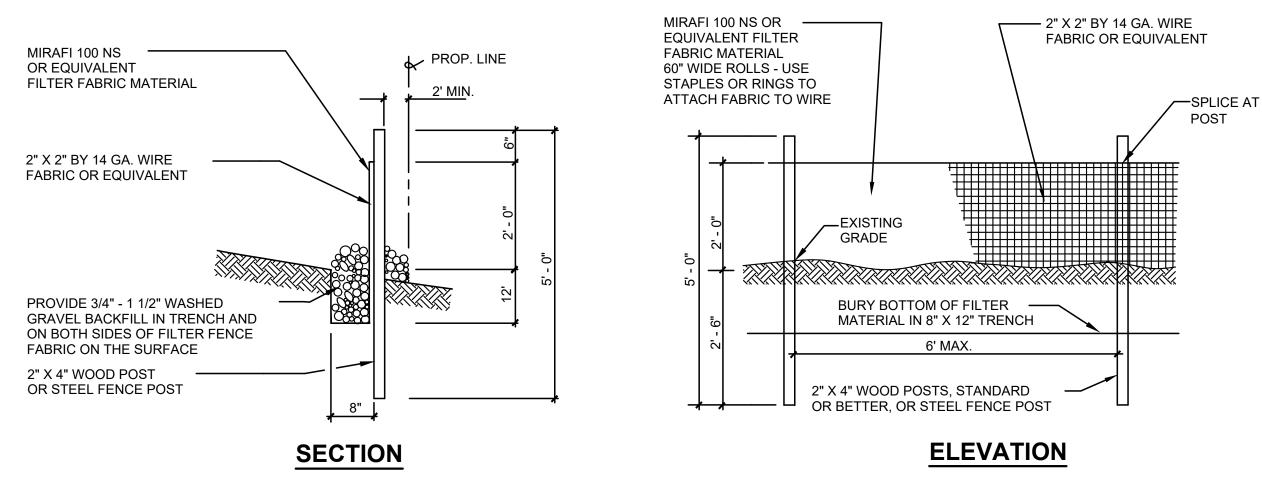






VANCOUVER, WA 98665 (360) 571-3350



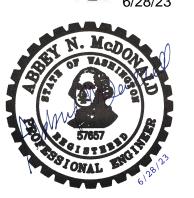



TOWN OF CATHLAMET

BOEGE ROAD AND SR 4 PRV STATIONS


No. DATE REVISION

JUNE 2023

ISSUED FOR:
BID AND CONSTRUCTION

ISSUE DATE:


APPROVED BY:	MBJ
CHECKED BY:	ANM
DRAWN BY:	RAH
DESIGNER:	ANM
G & O JOB NO.:	22239
FILE:	TESC.DWG

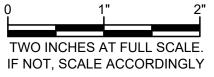



GENERAL

TEMPORARY EROSION
AND SEDIMENT
CONTROL NOTES AND
DETAILS

DRAWING: **G-6** OF: **9** 

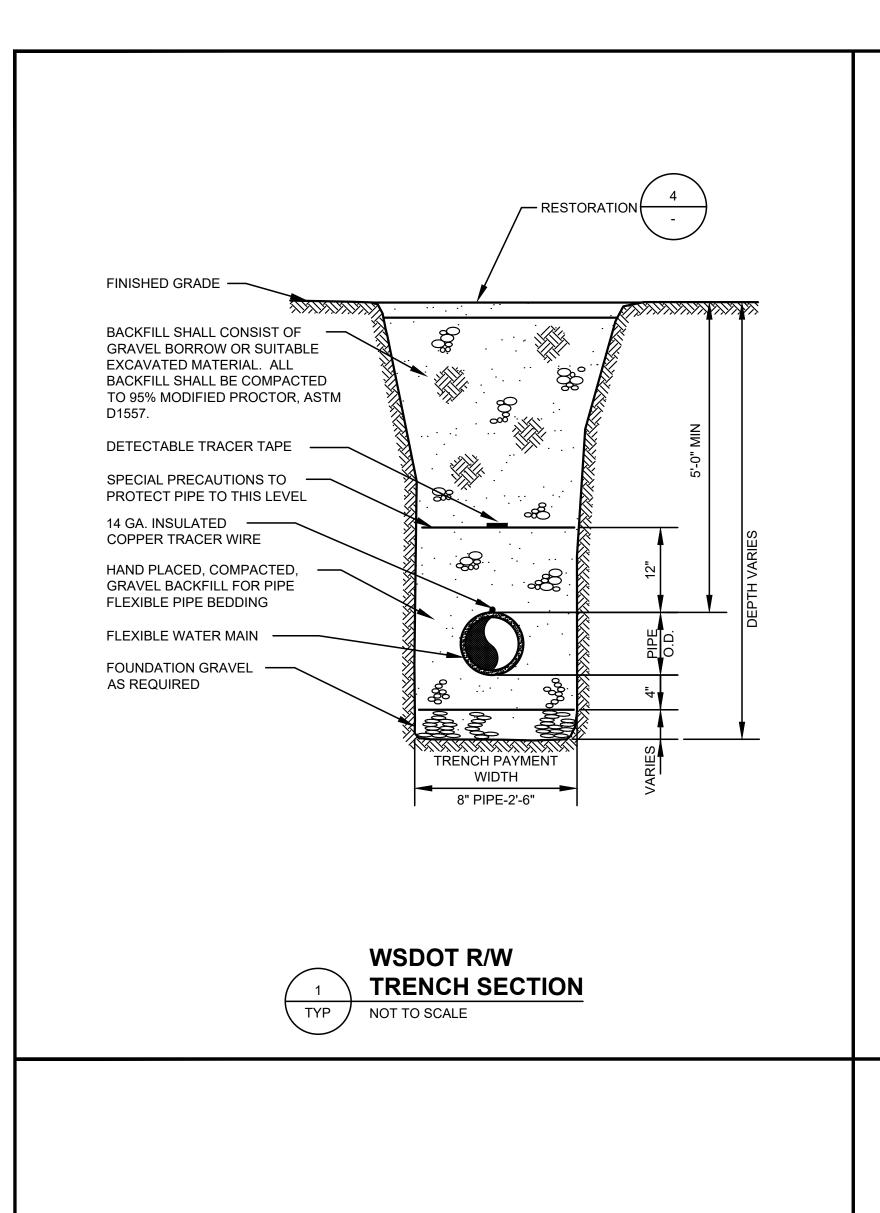

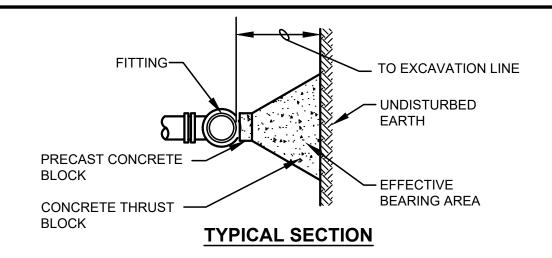

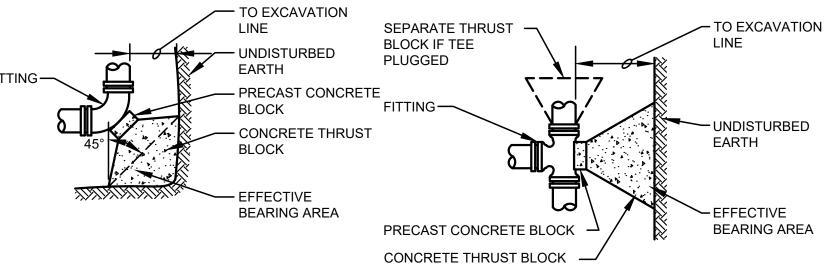

#### 90 EL PLAN **TEE PLAN** EFFECTIVE BEARING AREA REQUIRE

				<del></del>	
FITTING D	TEE	90°	45°	22½°	11½°
6"	4 SQ. FT.	6 SQ. FT.	3 SQ. FT.	2 SQ. FT.	2 SQ. FT.
8"	7 SQ. FT.	10 SQ. FT.	6 SQ. FT.	3 SQ. FT.	2 SQ. FT.


TYPICAL FOR SANDY SOIL WITH 2,000 P.S.F. BEARING STRENGTH & 100 P.S.I. WORKING PRESSURE. ADJUST BEARING AREA BY PRESSURE & SOIL BEARING CAPACITY. USE TEE FOR DEAD ENDS

#### NOTES:

- 1. BLOCKING SHALL BE TO SOLID BEARING SURFACE.
- 2. FITTING SHALL BE PROTECTED WITH A POLYTHLENE ENCASEMENT.
- 3. BEARING ARE SHALL BE PROPORTIONALLY INCREASED WITH PRESSURES IN EXCESS OF 100 P.S.I OR IN SOIL CONDITIONS WITH LESS THAN 2,000 P.S.F BEARING STRENGTH.
- 4. ALL BLOCKS ON TEES SHALL BE SEPARATED FOR DIRECTION OF THRUST.



THRUST BLOCKING

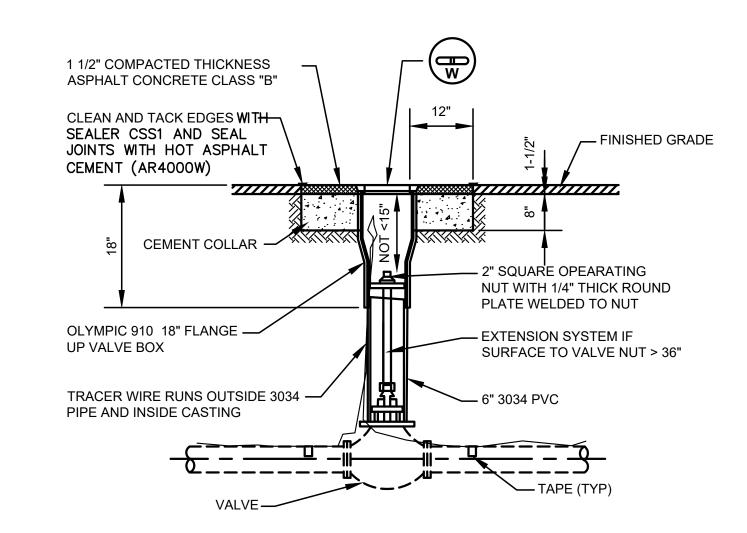

**VALVE BOX W/ WIRE DETAIL** 

3" OPEN PATTERN

RETURN BEND

3" BEEHIVE STRAINER W/ 24 **GAUGE MESH** 

SCREEN

PAINT YELLOW

THAT PORTION ABOVE GROUND

— 2' X 2' X 1' THICK

SPALLS

PAD OF QUARRY

NOT TO SCALE

2'-0"

3" DUCTILE IRON,

3" DUCTILE IRON (FLXFL) -

WITH WEEP HOLE

RESTRAINED JOINT

Gray & Osborne, Inc.

8513 NE HAZEL DELL AVENUE,


SUITE 202 VANCOUVER, WA 98665

(360) 571-3350

CATHLAME **TOWN OF** 


**CATHLAMET** 

**BOEGE ROAD** AND SR 4 **PRV STATIONS** 

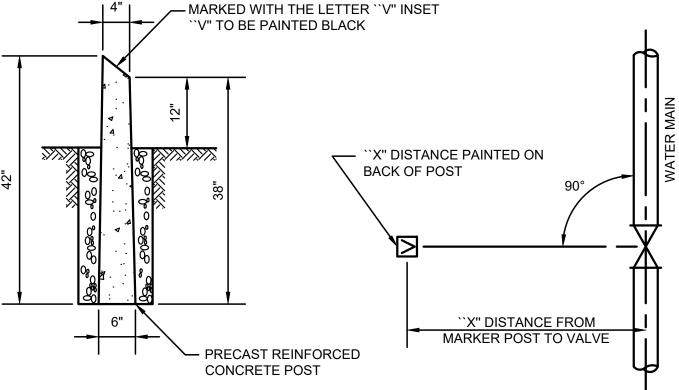


#### NOTES:

- PAINTED ON THE BACKSIDE OF THE MARKER POST IN BLACK WITH A 2"
- IS LOCATED IN AN UNPAVED AREA.
- 4. THE POST WILL ALSO BE REQUIRED FOR BLOW-OFF IN THE SAME CONDITION

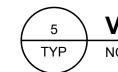

**VALVE MARKER POST** 

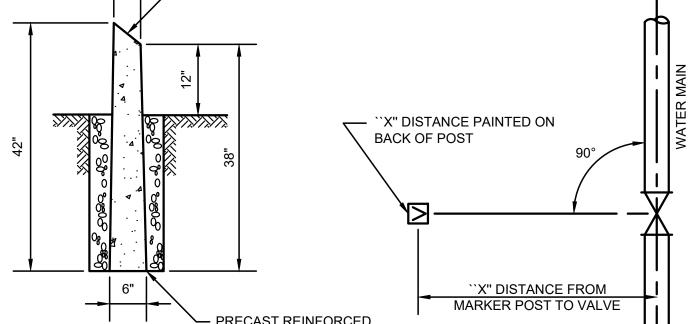

1. PRECAST REINFORCED POST TO BE PAINTED FLAT TRAFFIC YELLOW #2612

OR SAFETY YELLOW #1063.

2. THE DISTANCE FROM THE MARKER POST TO THE WATER MAIN SHALL BE HIGH NUMBER.

3. VALVE MARKER POST SHALL BE REQUIRED WHENEVER THE WATER VALVE

AS WATER VALVES.

PRESSURE RELIEF PIPING NOT TO SCALE

WATER DETAILS

No. DATE REVISION ISSUED FOR: BID AND CONSTRUCTION

ISSUE DATE: JUNE 2023 APPROVED BY: ANM CHECKED BY: DRAWN BY: RAH DESIGNER: ANM G & O JOB NO.: 22239 GEN\_DET.DWG

TWO INCHES AT FULL SCALE IF NOT, SCALE ACCORDINGLY

**GENERAL** 

TRENCHING, RESTORATION, AND

DRAWING: G-7 OF: 9

BACKFILL COMPACTED TO 95%

MODIFIED PROCTOR

HYDROSEED PER —

6" DEPTH STRIPPINGS

IMPORTED TOPSOIL PER SPECIFICATIONS


FROM ON-SITE OR

**SPECIFICATIONS** 

**HYDROSEED RESTORATION** NOT TO SCALE

MAX RESTORATION 5'-0" OR AS SHOWN ON PLANS

NOT TO SCALE

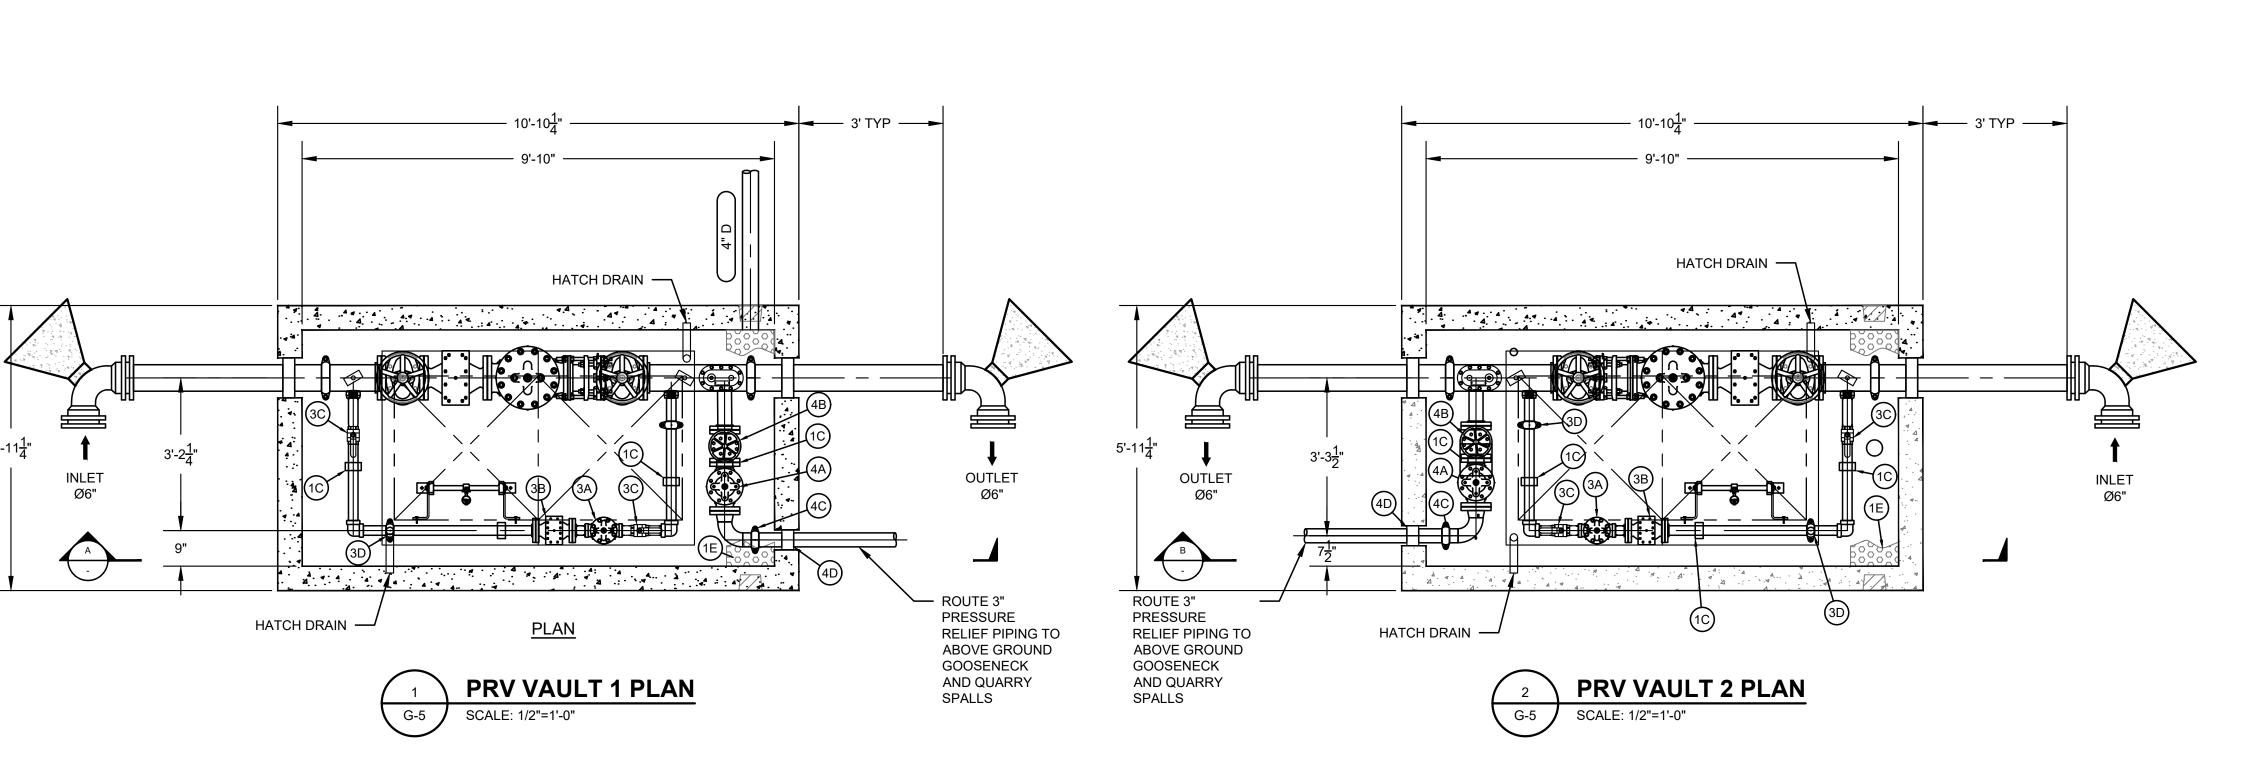

STRAINER W/ 24

GAUGE MESH

SCREEN, TYP.

IE=226.53

\_\_\_ 2" GALV STEEL


ROUTE 1 1/2" PVC

HATCH DRAIN

TO DRAIN

<u>Ψ</u> EL=229.52


4" D

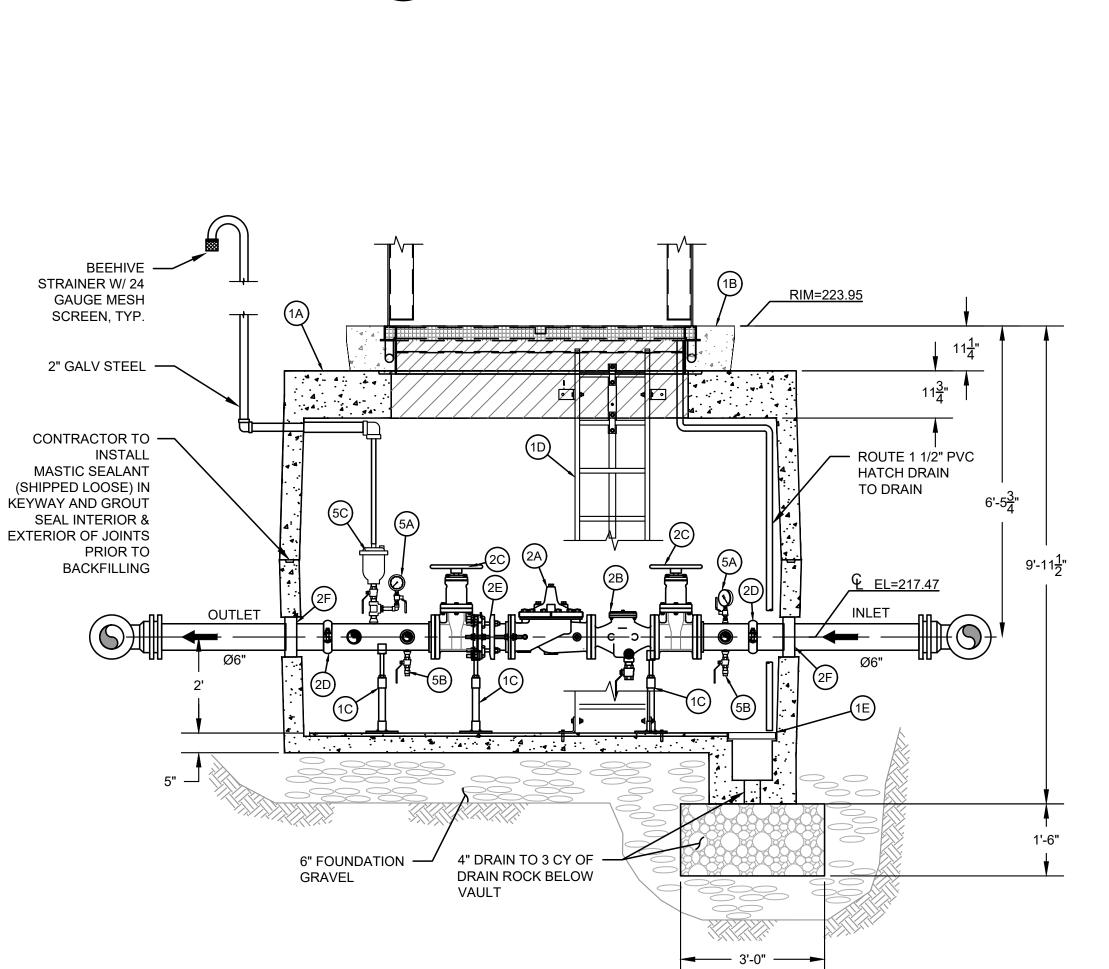

**PRV VAULT 2 SECTION** 

(2" BYPASS REMOVED FOR CLARITY)

SCALE: 1/2"=1'-0"

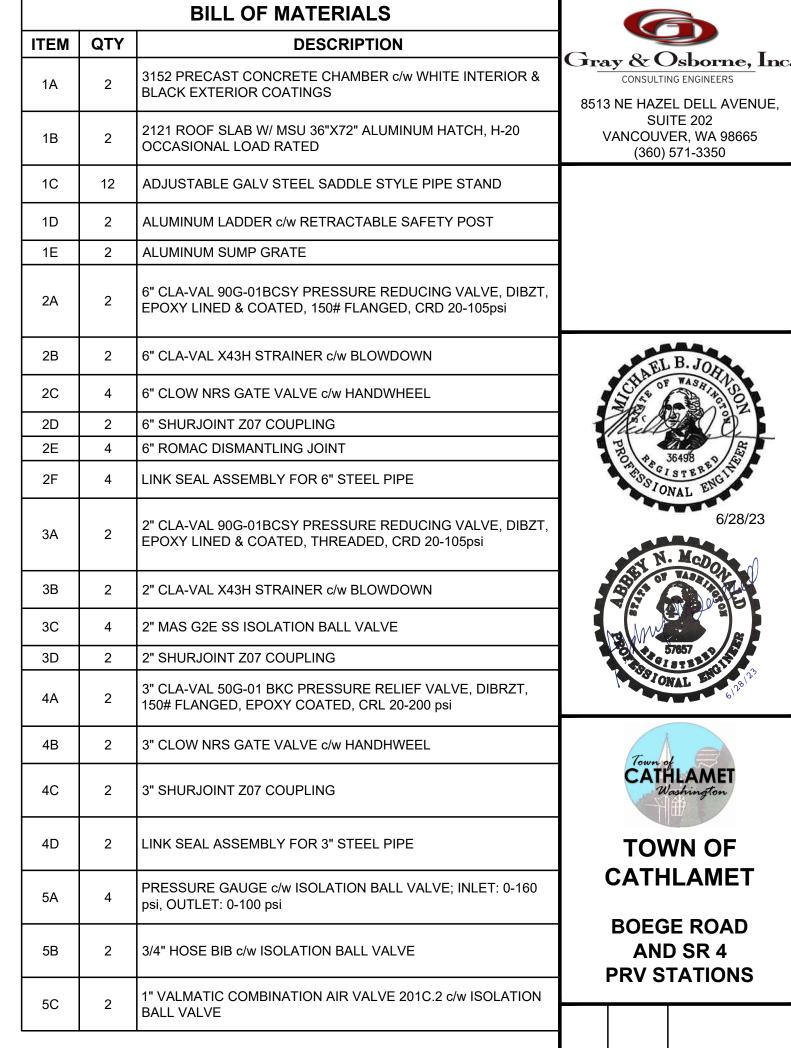

#### NOTES:

FABRICATED STEEL PIPE & FITTINGS ARE SCHEDULE NO. 40 STEEL PIPE FOR SIZES TO 10". FLANGES ARE ANSI 125/150 AND FASTENED WITH SS ASTM F-593 BOLTS, F-594 NUTS & SAE WASHERS.

ALL 2" AND SMALLER PIPE & FITTINGS ARE THREADED 304 STAINLESS STEEL.

ALL 3" AND LARGER PIPE, INSIDE WETTED SURFACES ARE SANDBLASTED, FUSION EPOXY LINED AND COATED TO AWWA C-213 AND NSF-61 SPECIFICATION. FINISH COATING IS BLUE.

VAULTS AND HATCHES SHALL BE RATED FOR H20 TRAFFIC LOADING

2	BLACK EXTERIOR COATINGS  8513 NE HAZEL DELL AVE			
2	2121 ROOF SLAB W/ MSU 36"X72" ALUMINUM HATCH, H-20 OCCASIONAL LOAD RATED	SUITE 202 VANCOUVER, WA 98665 (360) 571-3350		
12	ADJUSTABLE GALV STEEL SADDLE STYLE PIPE STAND			
2	ALUMINUM LADDER c/w RETRACTABLE SAFETY POST			
2	ALUMINUM SUMP GRATE			
2	6" CLA-VAL 90G-01BCSY PRESSURE REDUCING VALVE, DIBZT, EPOXY LINED & COATED, 150# FLANGED, CRD 20-105psi			
2	6" CLA-VAL X43H STRAINER c/w BLOWDOWN	EI	B. JOB.	
4	6" CLOW NRS GATE VALVE c/w HANDWHEEL	Silve of	ASH TAGE	
2	6" SHURJOINT Z07 COUPLING	Till.	2 / a	
4	6" ROMAC DISMANTLING JOINT	JOS JONAL ENGIN		
4	LINK SEAL ASSEMBLY FOR 6" STEEL PIPE			
2	2" CLA-VAL 90G-01BCSY PRESSURE REDUCING VALVE, DIBZT, EPOXY LINED & COATED, THREADED, CRD 20-105psi	JAN N	6/28/23	
2	2" CLA-VAL X43H STRAINER c/w BLOWDOWN			
4	2" MAS G2E SS ISOLATION BALL VALVE	May May		
2	2" SHURJOINT Z07 COUPLING	a silve	57657 81132	
2	3" CLA-VAL 50G-01 BKC PRESSURE RELIEF VALVE, DIBRZT, 150# FLANGED, EPOXY COATED, CRL 20-200 psi	0810	WAL SHE GIRS 123	
2	3" CLOW NRS GATE VALVE c/w HANDHWEEL	T		
2	3" SHURJOINT Z07 COUPLING	CATHLAMET Washington		
2	LINK SEAL ASSEMBLY FOR 3" STEEL PIPE		VN OF	
4	PRESSURE GAUGE c/w ISOLATION BALL VALVE; INLET: 0-160 psi, OUTLET: 0-100 psi	CATHLAMET		
2	3/4" HOSE BIB c/w ISOLATION BALL VALVE	BOEGE ROAD AND SR 4 PRV STATIONS		
2	1" VALMATIC COMBINATION AIR VALVE 201C.2 c/w ISOLATION BALL VALVE			

0.	DATE	REVISION

CONSULTING ENGINEERS

ISSUED FOR:

BID AND CONSTRUCTION

ISSUE DATE: JUNE 2023 APPROVED BY: CHECKED BY: ANM

RAH DRAWN BY: ANM DESIGNER: G & O JOB NO.: 22239

PRV\_VAULTS.DWG

TWO INCHES AT FULL SCALE. IF NOT, SCALE ACCORDINGLY

**GENERAL** 

PRV 1 AND PRV 2 **VAULT PLANS AND** SECTIONS

DRAWING: **G-8** OF: **9** 

6" FOUNDATION

GRAVEL

CONTRACTOR TO —

MASTIC SEALANT

SEAL INTERIOR &

(SHIPPED LOOSE) IN

KEYWAY AND GROUT


EXTERIOR OF JOINTS


INSTALL


PRIOR TO

BACKFILLING

**PRV VAULT 1 SECTION** SCALE: 1/2"=1'-0" (2" BYPASS REMOVED FOR CLARITY)

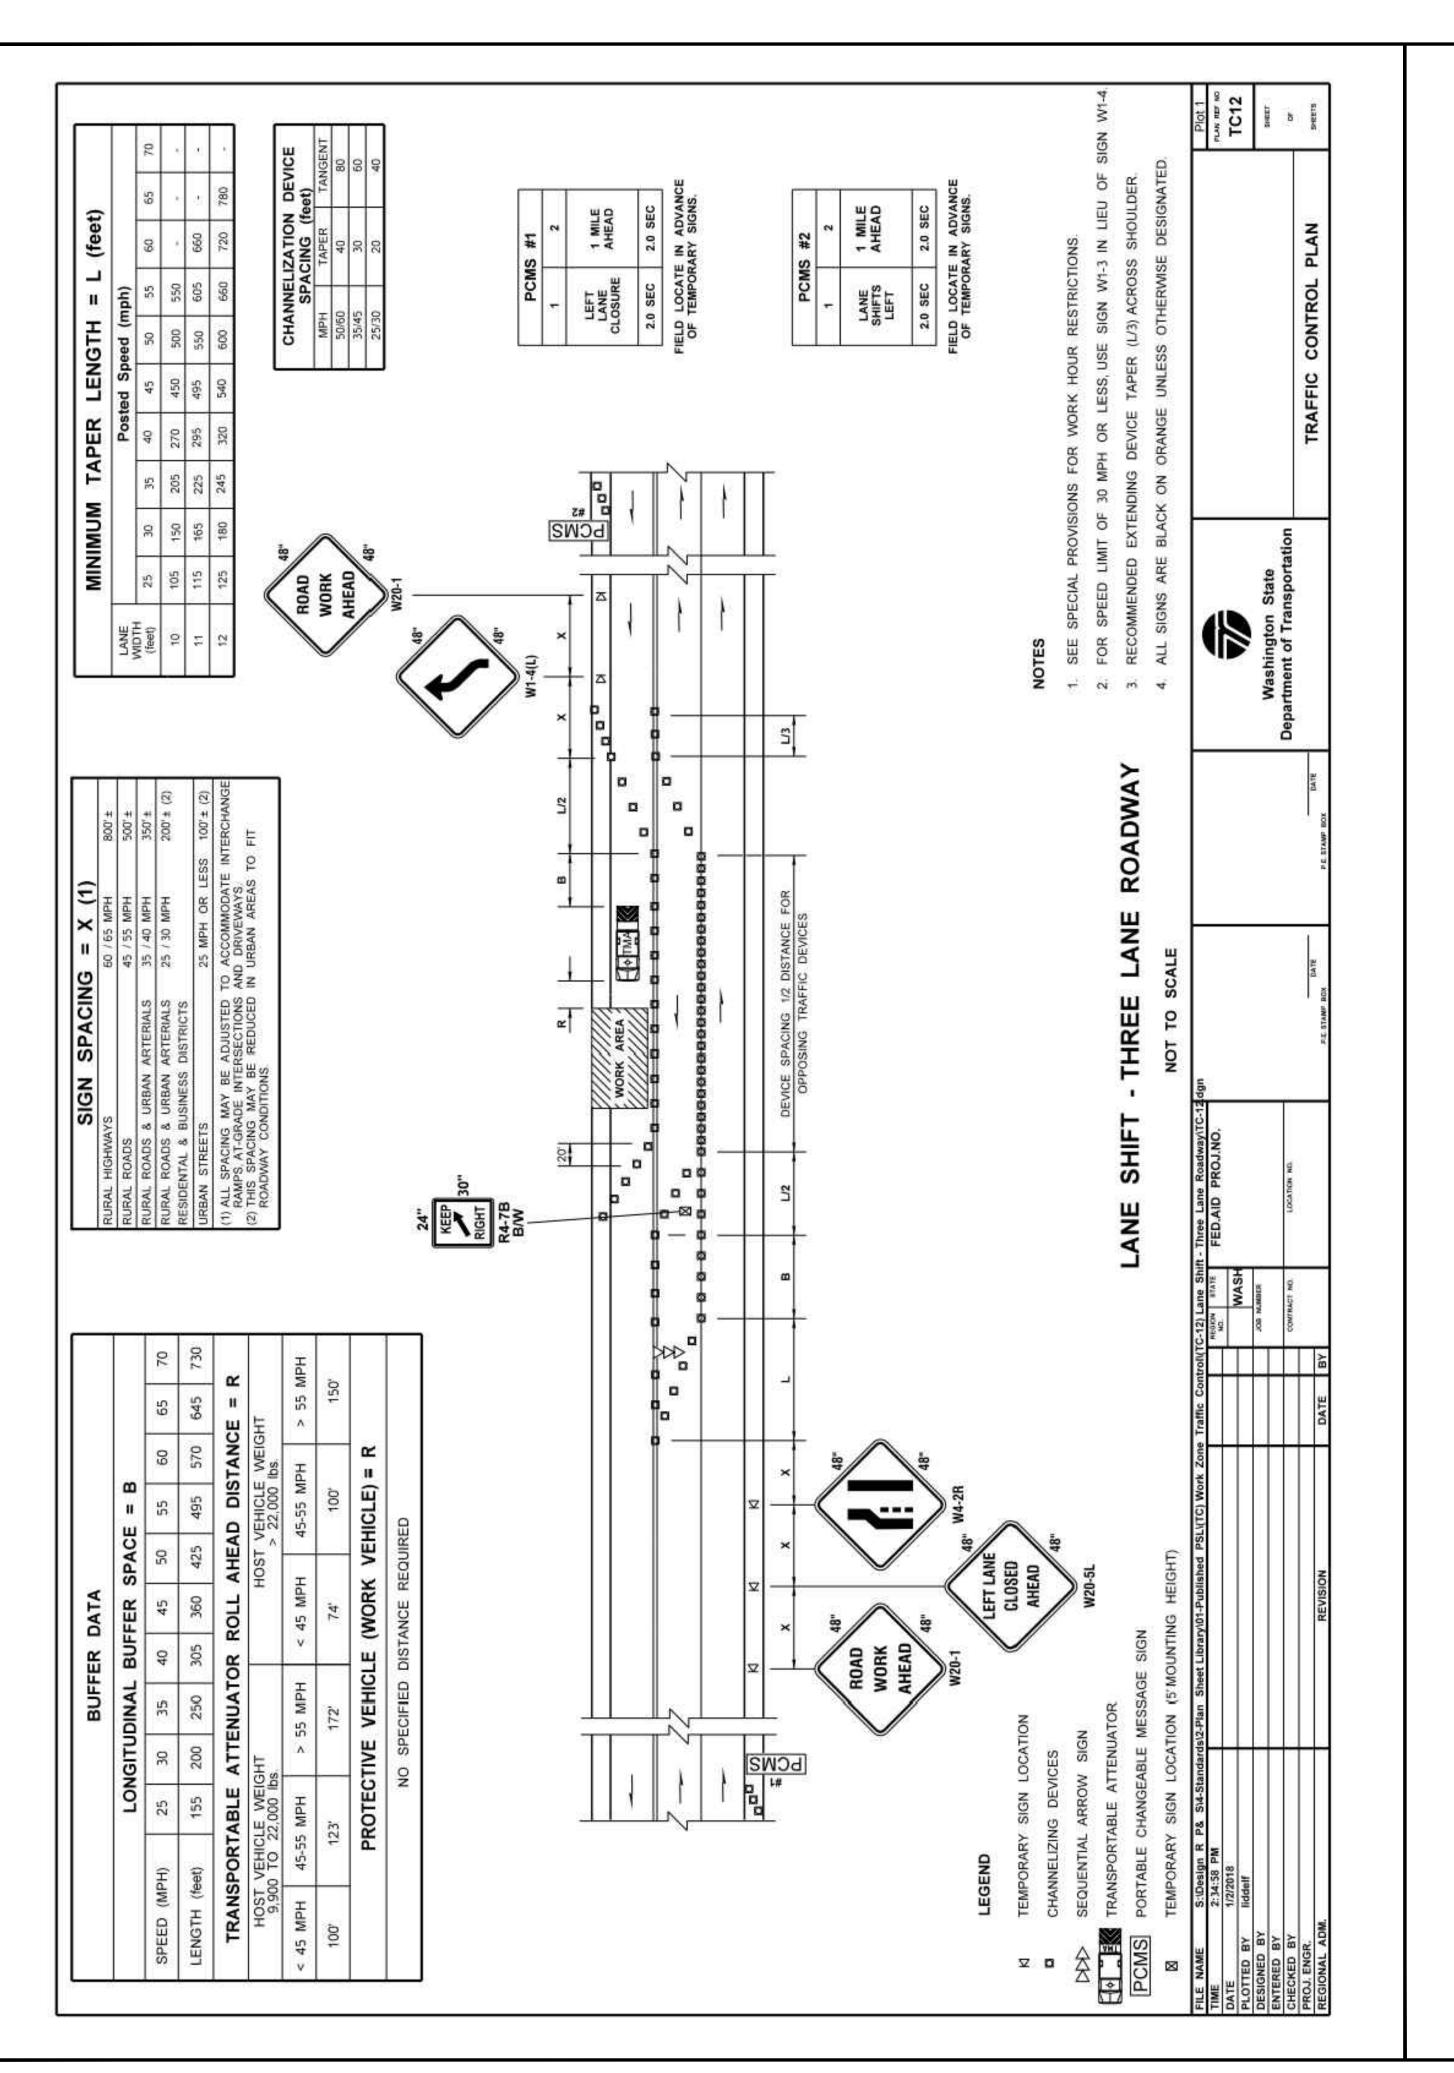

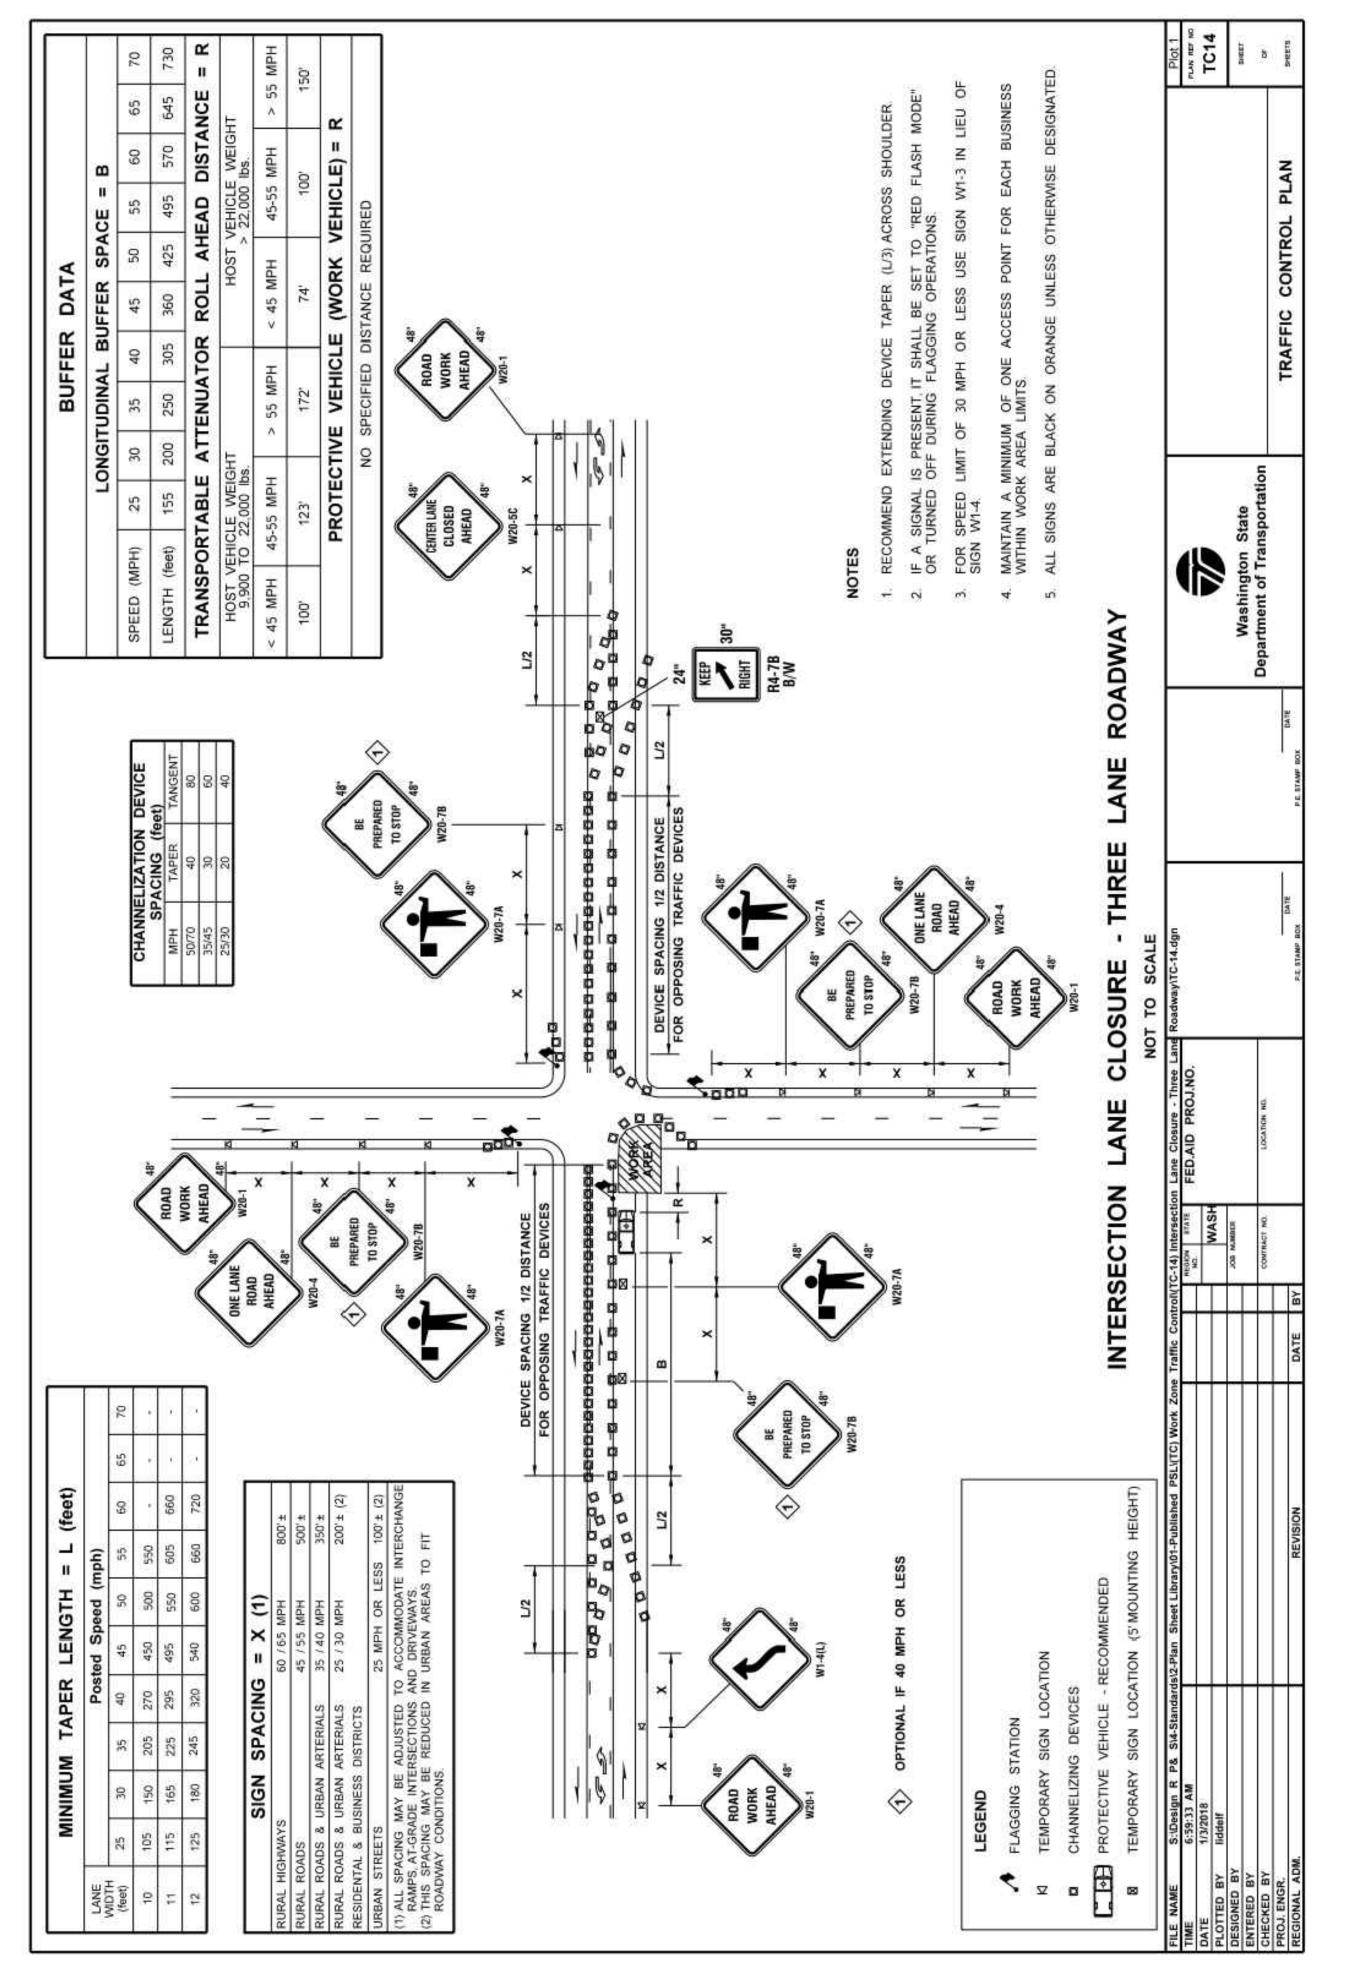

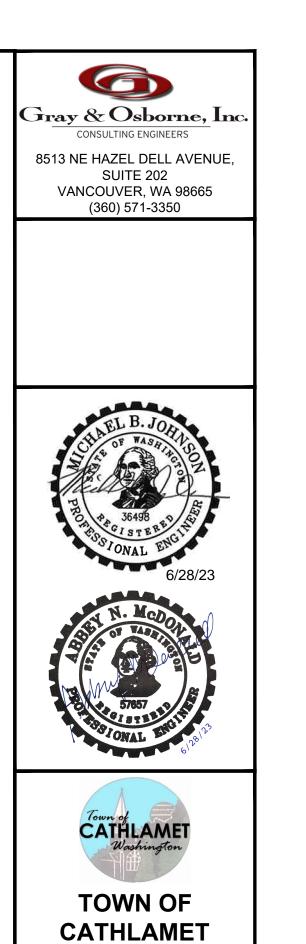

**BOEGE ROAD** AND SR 4

**PRV STATIONS** 

ISSUED FOR: BID AND CONSTRUCTION JUNE 2023 ISSUE DATE: APPROVED BY: ANM CHECKED BY: RAH ANM DRAWN BY: DESIGNER: 22239 G & O JOB NO.: TRAF\_CTRL.DWG TWO INCHES AT FULL SCALE.
IF NOT, SCALE ACCORDINGLY

REVISION

No. DATE

**GENERAL** 

TRAFFIC CONTROL **PLAN** 

DRAWING: **G-9** OF: **9**